AMENDED DA CLAUSE 4.55 PROPOSED TWO STOREY ATTACHED DUPLEX 11 HARDEN CRS GEORGES HALL



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project PROPOSED ATTACHED DUAL

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Mr HAYDAR ALI

OCCUPANCY AMENDED DA CLAUSE 4.55 Sheet Title:				
Client	Address	Scale	1.1	
	11 HARDEN CRES GEORGES			

HALL LOT 22 DP236764


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Jumber	Drawing Name	ISSUE
	COVER	
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S.r.	DEMOLITION PLAN	
	SUBGIVISION PLAN	
	DNTROL PLAN	
	THE PLACE	
	GROUND FLOOR PLAN	
	FIRST FLOOR PLAN	
	ROOF PLAN	
1-	ELEVATIONS	
-+-	ELEVATIONS	
	SECTIONS	
	SECTION	
	CONCEPT LANDSCAPE PLAN	
	WINDOWS AND DOORS SCHEDULE	
	BASIX COMMITMENTS	
	STREETSCAPE & FENCE DETAIL	
	SHADOW DIAGRAMS	
	NOTIFICATION PLAN	

14 15 16

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Issue



PURPOSES UNTIL ISSUED BY THE DESIGNER FOR CONSTRUCTION. ALL PRICING MUST ALLOWED FOR ALL ITEMS SPECIFIED. DO NOT SCALE FROM DRAWING. ANY VARIATIONS TO SPECIFICATIONS AND DRAFTINGS MUST BE AUTHORISED BY THE CLIENT. COPYRIGHT OF THESE DESIGNS. DRAFTINGS AND SPECIFICATIONS ARE COPYRIGHT AND ARE THE PROPERTY OF AKTREUM BUILDING DESIGNERS. THEY MUST NOT BE USED, REPRODUCED OR COPIED WHOLLY OR IN PART WITHOUT THE WRITTEN PERMISSON OF THE OWNERS. THE USE OF THESE DRAWINGS ARE UNDER ALL CONDITIONS USED ABOVE, CONTACT ADAM NASSER 0435237853

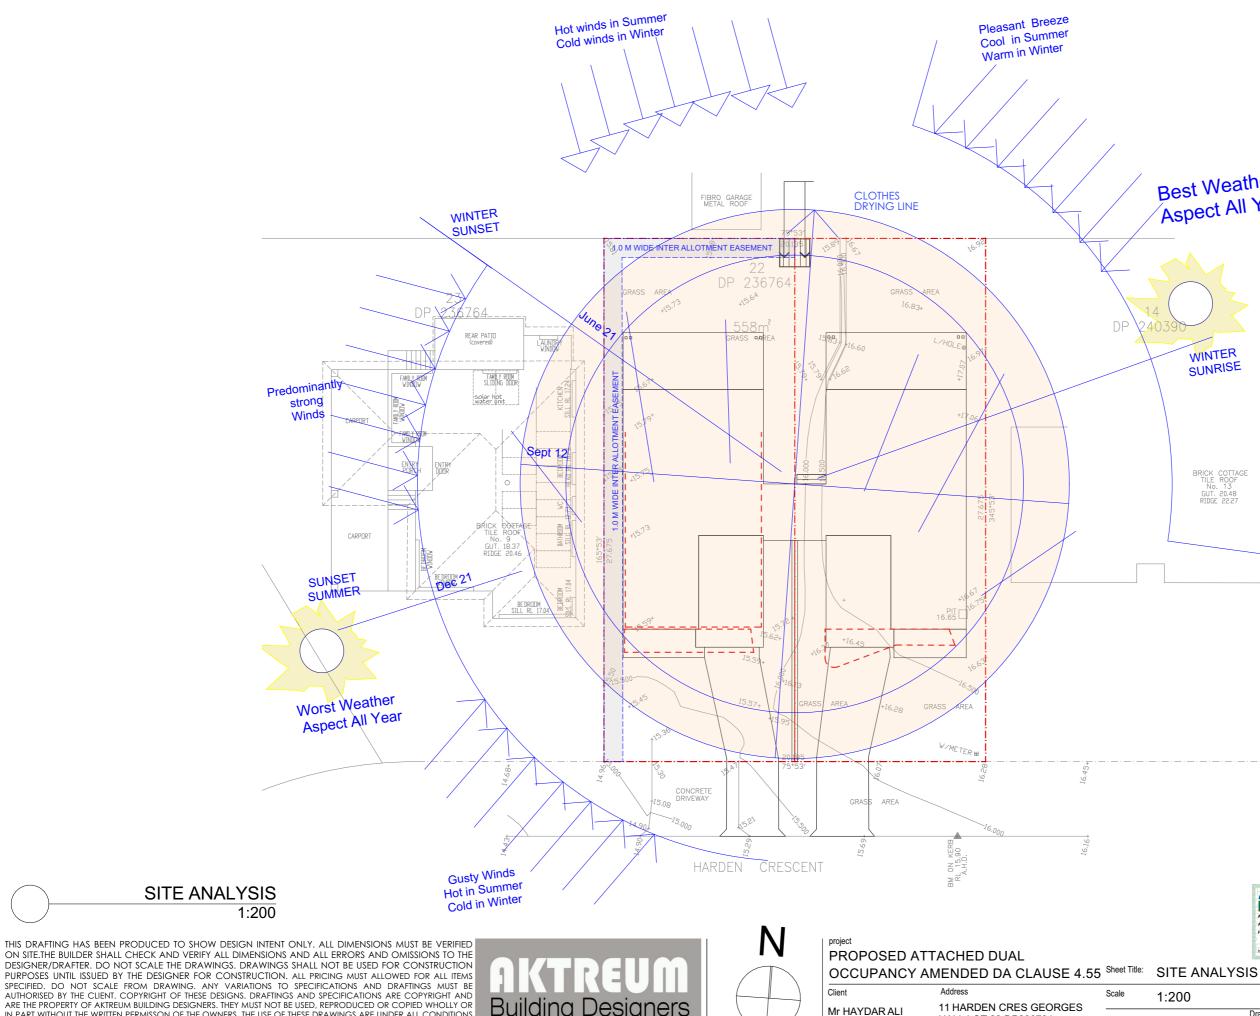

Best Weather Aspect All Year



BRICK COTTAG TILE ROOF No. 13 GUT. 20.48 RIDGE 22.27



F

Issue

HALL LOT 22 DP236764

Drawing No. 11 hardencres Date/Revision

05/01/25

SEDIMENTATION CONTROL NOTES ALL EROSION AND SEDIMENTATION CONTROL MEASURE, INCLUDING REVEGETATION AND STORAGE OF SOIL AND TOPSOIL, SHALL BE IMPLEMENTED TO THE STANDARDS OF THE SOIL CONSERVATION OF NSW. 2. DRAINAGE WORKS SHALL BE CONSTRUCTED AROUND ALL INLET PITS, CONSISTING OF 300MM W X 300MM D TRENCH. 3. ALL SEDIMENT BASINS AND TRAPS SHALL BE CLEANED WHEN AT A FIBRO GARAGE METAL ROOF MAXIMUM OF 60% FULL OF SOIL MATERIALS. 4. ALL DISTURBED AREAS SHALL BE REVEGETATED AS SOON AS THE RELEVANT WORKS ARE COMPLETED. 75°53' 5. SOIL AND TOPSOIL STOCKPILES SHALL BE LOCATED AWAY FROM DRAINAGE 15,891 20.185 Ъ, LINES AND AREAS WHERE WATER MAY CONCENTRATE. 6. FILTER SHALL BE CONSTRUCTED BY STRETCHING A FILTER FABRIC 22 (PROPEX OR EQUIVALENT) BETWEEN POSTS AT 2M CENTRES. FABRIC SHALL DP 236764 BE BURIED 200MM ALONG THE BOTTOM EDGE. GRASS AREA GRASS AREA +15.64 23 23676 +15,73 16.83+ NB: PLACE GRAVEL SAUSAGE 558m² Existing Shed to be AROUND THE NEAREST REAR PATID (covered) GRASS ARE 15,83 L∕HOLE⊛ KERB & demolished and DOWNSTREAM COUNCIL 6.rn 16.97 GUTTER removed STORMWATER PIT IN ASCOT STREET COUNCIL FAMILY ROOM 15. PIT CONCRETE AREA 15.66 solar hot water unit GRAVEL SAUSAGE: 7.06 BLUE METAL WRAPPED 15 IN GEOTEXTILE FABRIC AREA NB: WHEN SOIL AND SAND BUILDS UP SINGLE STOREY AROUND GRAVEL 27.675 345*53' CLAD HOUSE TILED SAUSAGE, THIS ROOF TO BE SHOULD BE DISPOSED **GRAVEL SAUSAGE - GUTTER PROTECTION** REMOVED AND ON-SITE NOT DOWN N.T.S. DEMOLISHED THE GUTTER. 165•53' 27.675 BEDROOM WINDOW Geotextile Filter Fabric 2000mm MAXIMUM OC LOWER FLOOR LEVEL: 15.7 SL 16.65 BEDROOM SILL RL 17.04 Disturbed Area GARAGE LEVEL: 15.60 AREA CRETE 15.62 16,45 631 15,59 \$15.5 6,13 Geotextile Filter Fabric 15.45 15,57 GRASS Undisturbed Area to be buried 200mm Materia ARE Existing concrete minimum into ground Storage +15,9 pathway to be el star pickets or similar driven into ground min 600mm, attached to Area demolished and geotextile filter fabric with wire ties removed METERN 75°53 BERM (0.3m MIN. HEIGHT CONSTRUCTION SITE IN LENGT CONCRETE DRIVEWAY Security construction Fence GRASS AREA 5.00 MIN WIDTH 3 GEOTEXTILE FABRIC 14,90 ON KERI - 15.90 A.H.D. EXISTING POADWA EXIT / ENTRANCE RUNOFF DIRECTED TO SEDIMENT TRAP HARDEN CRESCEN TEMPORARY CONSTRUCTION N.T.S. NOTE IN ACCORDANCE WITH SECTION 80 A (11) OF THE ENVIRONMENTAL PLANNING & ASSESSMENT ACT 1979 AND CLAUSE 98 OF THE ENVIRONMENTAL PLANNING & ASSESSMENT REGULATION 2000, IT IS A PRESCRIBED CONDITION THAT ALL BUILDING WORK MUST BE CARRIED OUT IN ACCORDANCE WITH THE PROVISIONS OF THE BUILDING CODE OF AUSTRALIA (BCA). Certificate No. #HR-B6L8K6-02 Certificate No. #HR-VMUJ5D-02 DEMOLITION WORK NOTE: A DEMOLITION WORK MUST BE IN ACCORDANCE WITH AUSTRALIAN STANDARD AS2601-2001, DEMOLITION OF STRUCTURES AND RELEVANT ENVIRONMENTAL / OCCUPATIONAL HEALTH AND SAFETY REQUIREMENTS. project THIS DRAFTING HAS BEEN PRODUCED TO SHOW DESIGN INTENT ONLY. ALL DIMENSIONS MUST BE VERIFIED ON SITE.THE BUILDER SHALL CHECK AND VERIFY ALL DIMENSIONS AND ALL ERRORS AND OMISSIONS TO THE

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PROPOSED ATTACHED DUAL

OCCUPANCY AMENDED DA CLAUSE 4.55 Sheet Title:

Client	Address	Scale	1:20
Mr HAYDAR ALI	11 HARDEN CRES GEORGES HALL LOT 22 DP236764	Issue	F

Construction Management Plan

The following Construction Management Plan will highlight the following:

-Location of material storage. -Location of any plant & equipment (cranes,hoists.etc)

-Maximum intended weight and size of construction and delivery vehicles

-Intended timing of deliveries to site

-Contact details for of person with authority to respond to any construction related access issues.

-Intended communication of construction details to adjoining residents -Details of any signage to be erected on the site

Location of any plant or equipment

Plant and equipment (cranes, hoists, rubbish bins etc) will be located in Location "B" (front yard) to avoid damage to existing established landscape to the rear of the

NOTE - Use of plant & equipment is to be timed so that material storage does not interfere with locating plant or equipment in the required area.

Construction and delivery vehicles

Construction vehicles will generally take the shape of trade utes/vans. Delivery vehicles are to be of fixed tray type with maximum weight of 3 tonnes. Concrete delivery is to be in the more of mini-mix vehicle. Rubbish bins are to be limited to 4 cubic metre bins during demolition stage and reduced to 3 cubic metre bins for general site cleaning as necessary.

Vehicle access and egress

Construction vehicles (utes/vans) can access and earess the site without any special requirements. Delivery trucks are not to enter the site and must stay on the public, road to avoid damage to road crossing, footpath and or driveway.

Material delivery and handling

Materials delivered to site are to be unloaded from delivery truck on site wherever possible and stored in appropriate location as specified immediately. Where unloading is not possible on site materials are to be unloaded at street level and manually carried onto site and stored in appropriate locations as specified immediately

NOTE- At no time are materials to be stored on the road, access handle, nature strip or adjoining properties.

Hours of Work

All Construction /Demolition work relating to the Development Consent within the city must be carried out between the hours of 7:00am to 5:00pm Mondays to Fridays and 7:00am to 12:00 noon on Saturday. No work is to be done on Sunday and Public Holidays, Refer Council's DA Determination Notes.

Timing of deliveries

Material deliveries will generally take place between 8:00am and 3:00pm the day before the materials will be required on site.

Communication with adjoining residents

Upon receipt of the Construction Certificate the adjoining residents will be notified that works are being arranged to begin. This will provide approximately 3 weeks' notice in this regard. This notification will include all contact details per above. Further to this the Construction Supervisor will introduce himself to these residents a minimum of 48 hours prior to commencement.

Location of Material Storage

Materials will be stored on site in locations marked or shown Below:

Location marked = (side access for proposed driveway) heavy/bulky materials such as bricks/steel/roof tiles etc will be stored in this area in order to allow lifting off delivery truck and placement for storage without "double handling" of materials. Timber/Pre-Fabricated frames and trusses etc will be stored on the front lawn. These materials are generally of longer lengths and light enough to allow manual handling from delivery truck to storage area.

Location "C" - New floor platform- internal finishing materials

(Skirting/architraves/doors etc_ will be stored internally within the new area as directed by the builder for protection from weather. Fragile materials such as tiles. plumbing fittings and fixtures etc will be stored in the old study/bedroom area o r rooms not generally used by the proprietors so as to minimize possibility of damage and to provide security against theft.

NOTE - Material deliveries are to be timed so that only

materials required for the scope of works to be carried out at

that stage are on site in order to ensure the site is not cluttered and to allow easy access for trades/residents to and from the site.

Signage

Signage in the form of a site sign to identify the Builder's and Architects names and contact details and the Principal certifying Authority will be required on site. The location of this signage is shown on the associated plans

Soil & Water Management Plans

All sediment controls are to be installed before work commence. Any areas of exposed soil are to be minimised. All top-soil is to be retained on site for re-use Material & soil stockpiles are to be protected sediment fencing. Stockpiles and work areas are to be as indicated by the Construction Management Plan to preserve existing vegetation. Surface water flows during construction are to be controlled as

- Clean run off is to be diverted around disturbed areas
- Disturbed areas are to be promptly rehabilitated
- Sediment fence are to be regularly monitored and manufactured during construction Slope gradient & flow distance are to be minimised

DEMOLITION PLAN

00

Date/Revision



	SUMMARY OF BAS	IX COMMITMENTS							su	
	Basix Certificate Numb	per: 1781102M - Unit 1							Bas	
Certificate Prepared E	By:							Certificate Prepared E	Bv:	
	Name/Company Name: G	Breen Choice Consulting							Name	
	ABN: 6365	58893415								
	WATER COM	IMITMENTS								
Landscape								Landscape		
Are	a of Garden & Lawn (m²)	50.00			20.185				a of Garden & Lawn (m ²)	
Area of Indige	enous or low water use species (m ²)	0.00		1.0	0 M WIDE INTER ALLOTMENT EASEMENT	10.0925		L	enous or low water use sp	
Fixtures					10,0005			Fixtures		
	Showerheads	4 star (> 4.5 but <= 6 L/	/min)		10.0925			- Interes	Showerheads	
	Toilet	6 star				-			Toilet	
	Kitchen Taps	6 star				•			Kitchen Taps	
	Bathroom Taps	6 star							Bathroom Taps	
Alternative Water								Alternative Water	Datiliooni Tapa	
	Rainwater Tank (L)	2000.00						Alternative water	Rainwater Tank (L)	
Colle	ected from Roof Area (m²)	135.00						Coll	ected from Roof Area (m ²	
Tank Connected To								Tank Connected To	ected IIOIII ROOI Alea (III	
	Toilets	No		1						
	Laundry	No		ME	Unit 1 279.31m ² Unit 2 279.31m ²			Toilets Laundry		
	Private Landscape	Yes		ASE						
F	Private Swimming Pool	N/A		Ш н				Private Landscape		
	Private Outdoor Spa	N/A							Private Swimming Pool	
	ENERGY COM	MMITMENTS		E			i i		Private Outdoor Spa	
Hot Water System	gas instantaneous	5 star		LL I			i	Het Weter Sustem	and instants	
	Living	1-phase airconditioning - non ducted	2.5 star	i A	Unit 1	Unit 2	i i	Hot Water System	gas instanta	
Cooling	Bedroom	1-phase airconditioning - non ducted	2.5 star	E E	279.31m ²	279.31m ²	i i	Cooling	Living	
	Living	1-phase airconditioning - non ducted	2.5 star	i iii			i i		Bedroo	
Heating	Bedroom	1-phase airconditioning - non ducted	2.5 star			Ì	i i	Heating	Living	
	Bathroom Exhaust	individual fan, ducted to facade or roof	manual switch on/off	N N N N N N N N N N N N N N N N N N N		İ	i.		Bedroo	
Ventilation	Kitchen Exhaust	individual fan, ducted to facade or roof	manual switch on/off	÷		İ			Bathroom E	
	Laundry Exhaust	individual fan, ducted to facade or roof	manual switch on/off	2		Ì	5	Ventilation	Kitchen Ex	
	Skylight or Window in Kitchen	yes	· · · · · · · · · · · · · · · · · · ·	.675			.675		Laundry Ex	
Natural Lighting	Skylight or Window in Bathrooms/Toilets	2		27			27	Natural Lighting	Skylight or Windo	
Alternative Energy	N/A						l.		Skylight or Window in I	
	OTHER COM	MITMENTS					ļ.	Alternative Energy	N/A	
	Cooktop/Oven	gas cooktop & electric o	oven			-	ļ.			
(Outdoor Clothes line	yes				-	ļ.		Cooktop/Oven	
	Indoor Clothes line	no				-	ļ.		Outdoor Clothes line	
									Indoor Clothes line	

20.185

10.0925

HARDEN CRESCENT

10.0925

SUBDIVISION PLAN 1:200

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Ν project PROPOSED ATTACHED DUAL OCCUPANCY AMENDED DA CLAUSE 4.55 Sheet Title: Client Address Scale 1:200 11 HARDEN CRES GEORGES Mr HAYDAR ALI HALL LOT 22 DP236764 Issue F

SUMMARY OF BASIX COMMITMENTS Basix Certificate Number: 1781102M - Unit 2

Basix Certificate Number: 1781102M - Unit 2						
Name/Company Name: Green Choice Consulting						
ABN: 63658893415						
WATER COMMITMENTS						
0.00						
A star (s. 4.5 but a . 0.1)	(i)					
,	min)					
6 star						
2000.00						
155.00						
No						
No						
Yes						
N/A						
N/A						
IMITMENTS						
5 star						
1-phase airconditioning - non ducted	2.5 star					
1-phase airconditioning - non ducted	2.5 star					
1-phase airconditioning - non ducted	2.5 star					
1-phase airconditioning - non ducted	2.5 star					
individual fan, ducted to façade or roof	manual switch on/off					
individual fan, ducted to façade or roof	manual switch on/off					
individual fan, ducted to façade or roof	manual switch on/off					
yes						
2						
	oven					
yes						
no						
	reen Choice Consulting 8893415 MITMENTS 50.00 0.00 4 star (> 4.5 but <= 6 L/ 6 star 6 star 2000.00 135.00 No No No Yes N/A N/A MITMENTS 5 star 1-phase airconditioning - non ducted 1-phase airconditioning					



SUBDIVISION PLAN

The following Construction Management Plan will highlight the following -Location of material storage.

-Location of any plant & equipment (cranes, hoists.etc) -Maximum intended weight and size of construction and delivery vehicles -Intended timing of deliveries to site

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Soil & Water Management Plans

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Clean run off is to be diverted around disturbed areas

Disturbed areas are to be promptly rehabilitated

Sediment fence are to be regularly monitored and manufactured during construction. Slope gradient & flow distance are to be minimised

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SEDIMENTATION CONTROL NOTES

NB: PLACE GRAVEL SAUSAGE

STORMWATER PIT IN ASCOT

AROUND THE NEAREST

DOWNSTREAM COUNCIL

STREET.

Geotextile Filter Fabric

to be buried 200mm

minimum into ground

GEOTEXTILE FABRIC

DEMOLITION WORK NOTE:

NOTE:

RUNOFE DIRECTED

TO SEDIMENT TRAP

ALL EROSION AND SEDIMENTATION CONTROL MEASURE, INCLUDING REVEGETATION AND STORAGE OF SOIL AND TOPSOIL, SHALL BE IMPLEMENTED TO THE STANDARDS OF THE SOIL CONSERVATION OF NSW.

2. DRAINAGE WORKS SHALL BE CONSTRUCTED AROUND ALL INLET PITS, CONSISTING OF 300MM W X 300MM D TRENCH.

3. ALL SEDIMENT BASINS AND TRAPS SHALL BE CLEANED WHEN AT A MAXIMUM OF 60% FULL OF SOIL MATERIALS.

4. ALL DISTURBED AREAS SHALL BE REVEGETATED AS SOON AS THE RELEVANT WORKS ARE COMPLETED.

5. SOIL AND TOPSOIL STOCKPILES SHALL BE LOCATED AWAY FROM DRAINAGE LINES AND AREAS WHERE WATER MAY CONCENTRATE.

6. FILTER SHALL BE CONSTRUCTED BY STRETCHING A FILTER FABRIC (PROPEX OR EQUIVALENT) BETWEEN POSTS AT 2M CENTRES. FABRIC SHALL BE BURIED 200MM ALONG THE BOTTOM EDGE.

N.T.S.

Disturbed Area

CONSTRUCTION SITE

PROVISIONS OF THE BUILDING CODE OF AUSTRALIA (BCA).

AS2601-2001, DEMOLITION OF STRUCTURES AND RELEVANT


Geotextile Filter Fabric 2000mm MAXIMUM OC

Undisturbed Area

BERM (0.3m MIN

N LENGTA 15

MIN WIDTH 3

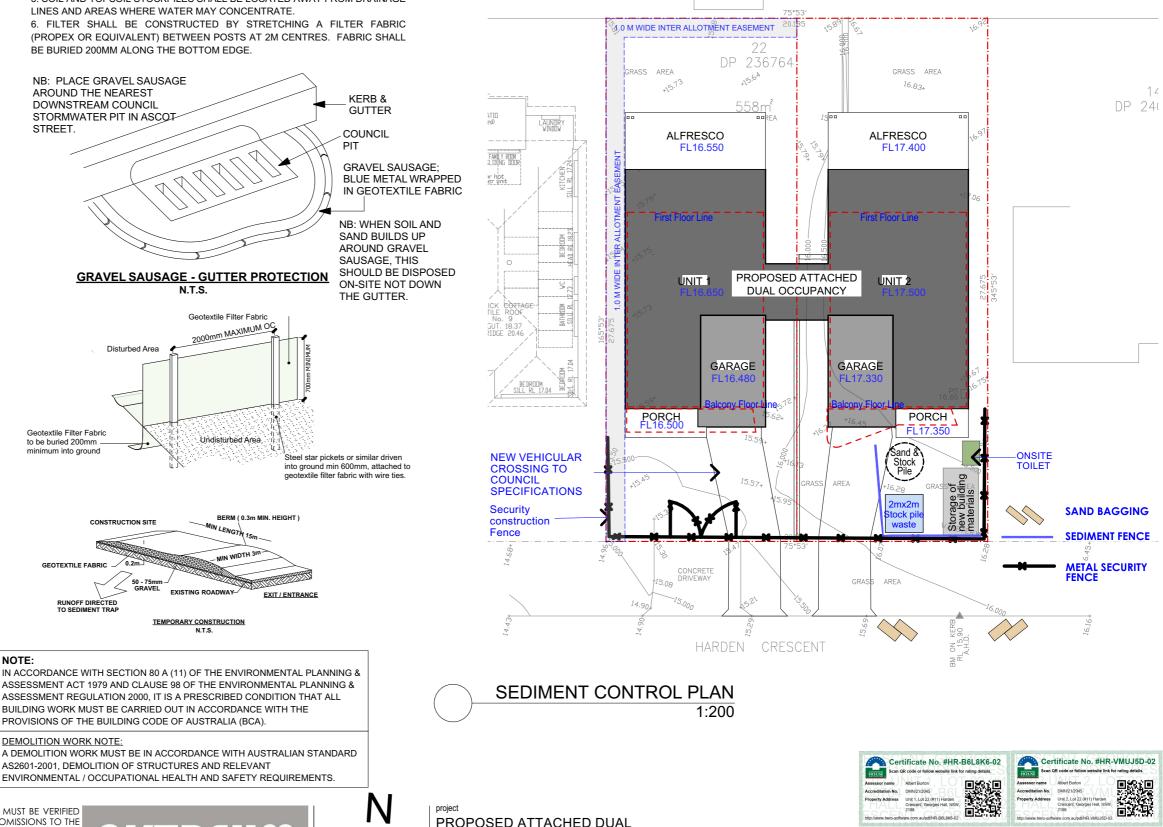

FIBRO GARAGE METAL ROOF



TEMPORARY CONSTRUCTION N.T.S.

OCCUPA	NCY AMENDED DA CLA	USE 4.55 Sheet Title:	SEI
Client	Address	Scale	1.0

Client	Address	Scale	1:20
Mr HAYDAR ALI	11 HARDEN CRES GEORGES HALL LOT 22 DP236764	Issue	F

DIMENT CONTROL PLAN

00

Date/Revision

05/01/25

ENVIRONMENTAL SITE MANAGEMENT NOTES

All existing trees to be retained unless shown otherwise on approved Architect's or Landscape drawings. Trees retained are to be protected with a high visibility fence, plus flagging to individual trees as necessary.

Retain all existing grass cover wherever possible.

Sediment and erosion controls must be in place prior to the commencement of any earthworks of demolition activity.

Install temporary sediment barriers to all inlet pits likely to collect silt laden water, until surrounding areas are paved or regrassed.

· All silt fences and barriers are to be maintained in good order and regularly desilted during the construction period.

· It is the responsibility of the contractor to ensure that all measures are taken during the course of construction to prevent sediment erosion and pollution of the downstream system. Supervising engineer should be contacted if in doubt.

· It is the responsibility of the contractor to ensure that all measures are taken during the course of construction to prevent sediment erosion and pollution of the downstream system. Supervising engineer should be contacted if in doubt. Waste materials are to be stockpiled or loaded into Utility vehicles located as shown on plan.

stockpiles of loose material such as sand, soil, gravel must be covered with geotextile silt fence material. Plastic sheeting or membrane must not be used. Safety barricading should be used to isolate stockpiles of solid materials such as steel reinforcing, formwork, scaffolding,

· All vehicles leaving the site must pass over the 'ballast' area to shake off site clay and soil. If necessary wheels and axles are to be hose down. Ballast is to be maintained and replaced as necessary during the construction period.

Delivery and other motor vehicles removing excavated material should travel on stabilised construction paths and material should be taken to the truck to reduce truck movement on the site.

Any sediment deposit on the public way, including footpath reserve and road surface, is to be removed immediately.

Provide barriers round all construction works within the footpath area to provide safe access for pedestrians.

Concrete pumps and cranes are to operate from within the ballast entry driveway area and are not to operate from the public roadway unless specific council permission is obtained.

· delivery vehicles must not stand within the public roadway for more than 20 minutes at a time.

Any excavation work adjacent to adjoining properties or the public roadway is not to be commenced until the structural engineer is consulted and specific instructions received from the engineer.

Toilet facilities must be either a flushing type or approved portable chemical closet. Chemical closets are to be maintained and serviced on a regular basis so that offensive odour is not emitted.

SEDIMENTATION CONTROL NOTES

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Soil Management

All excess soil on site generated as a result of necessary excavations to be re-used as fill to sub base of raft slab and to achieve a levelled building platform.

Termite Protection Note

Kordon Termite Barrier to be installed to perrimeter of building and to all drainage pipe penetrations

Soil Note

Slab Level to form Datum to be Determined on Site & to Existing FFL Retaining walls to be completed to engineers details (if required) Sewer connection to Existing Connection Dish drains (if Needed) to Authorities Details Smoke Alarms to be Mains Connected There are no existing trees to be removed.

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NOTE: KEEP FOOT PATH AND PUBLIC PEDESTRIAN AREA CLEAN AND CLEAR AT ALL TIMES

IMPORTANT NOTES CONDENSATION MANAGEMENT SHALL BE IN ACCORDANCE WITH NCC 2019 PART3.8.7 APPLY AN APPROPRIATE TERMITE MANAGEMENT SYSTEM IN ACCORDANCE WITH PART 3.1.3 OF THE NCC

NOTE: COUNCIL ISSUED FOOTWAY DESIGN LEVELS

COUNCIL'S ISSUED FOOTWAY DESIGN LEVELS TO BE INCORPORATED INTO THE FINISHED LEVELS ONCE ISSUED BY COUNCIL

NOTE: SERVICES

NO EXCAVATIONS TO BE CARRIED OUT WITHIN FOOTPATH AND PUBLIC PEDESTRIAN AREA WITHOUT CHECKING FOR DEPTH AND LOCATION OF SERVICES

1. ALL EROSION AND SEDIMENTATION CONTROL MEASURES, INCLUDING REVEGETATION AND STORAGE OF SOIL AND TOPSOIL. SHALL BE IMPLEMENTED TO THE STANDARDS OF THE SOIL CONSERVATION OF NSW.

2. ALL DRAINAGE WORKS SHALL BE CONSTRUCTED AND STABILIZED AS EARLY AS POSSIBLE DURING DEVELOPMENT. 3. SEDIMENT TRAPS SHALL BE CONSTRUCTED AROUND ALL INLET PITS, CONSISTING OF 300mm WIDE X 300mm DEEP TRENCH

4. ALL SEDIMENT BASINS AND TRAPS SHALL BE CLEANED WHEN THE STRUCTURES ARE A MAXIMUM OF 60 % FULL OF SOIL MATERIALS, INCLUDING THE MAINTENANCE PERIOD. 5. ALL DISTURBED AREAS SHALL BE REVEGITATED AS SOON AS THE RELEVANT WORKS ARE COMPLETED.

6. SOIL AND TOPSOIL STOCKPILES SHALL BE LOCATED AWAY FROM DRAINAGE LINES AND AREA WHERE WATER MAY CONCENTRATE.

7. FILTER SHALL BE CONSTRUCTED BY STRETCHING A FII TER

Disturbed Area

Geotextile Filter Fabric

mum into ground

to be buried 200mm


FABRIC (PROPEX OR APPROVED EQUIVALENT BETWEEN POST AT 3.0m CENTRES. FABRIC SHALL BE BURIED 150mm ALONG ITS LOWER EDGE.

> Geotextile Filter Fabric 2000mm MAXIMUM OC

> > Undisturbed Area

Steel star pickets or similar driven into ground min 600mm, attached to

geotextile filter fabric with wire ties.

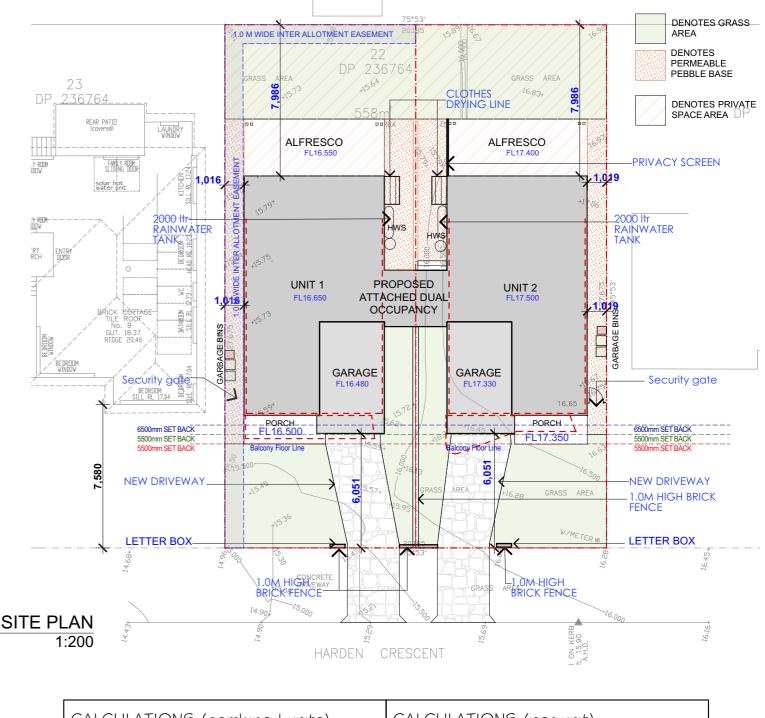

FIBRO GARAGE

CALCULATIONS (combined units)			CALC
TOTAL SITE AREA	=	558.62m ²	SITE A
TOTAL GROUND FLOOR AREA TOTAL FIRST FLOOR AREA		49.66m ² 29.64m ²	GROUI FIRST
TOTAL FLOOR AREA TOTAL F.S.R.	=	279.30m ² 0.500:1	TOTAL F.S.R.
GARAGE FLOOR AREA (per unit) PRIVATE OPEN AREA (per unit)	=	7. 5m ² 80.72m ²	GARAG PRIVAT



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OCCUPANCY AMENDED DA CLAUSE 4.55 Sheet Title:				
Client	Address 11 HARDEN CRES GEORGES	Scale	1:200	
Mr HAYDAR ALI	HALL LOT 22 DP236764	Issue	F	




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Date/Revision

Drawing No. 11 hardencres




ON SITE.THE BUILDER SHALL CHECK AND VERIFY ALL DIMENSIONS AND ALL ERRORS AND OMISSIONS TO THE DESIGNER/DRAFTER. DO NOT SCALE THE DRAWINGS. DRAWINGS SHALL NOT BE USED FOR CONSTRUCTION PURPOSES UNTIL ISSUED BY THE DESIGNER FOR CONSTRUCTION. ALL PRICING MUST ALLOWED FOR ALL ITEMS SPECIFIED DO NOT SCALE FROM DRAWING ANY VARIATIONS TO SPECIFICATIONS AND DRAFTINGS MUST BE AUTHORISED BY THE CLIENT. COPYRIGHT OF THESE DESIGNS. DRAFTINGS AND SPECIFICATIONS ARE COPYRIGHT AND ARE THE PROPERTY OF AKTREUM BUILDING DESIGNERS. THEY MUST NOT BE USED, REPRODUCED OR COPIED WHOLLY OR IN PART WITHOUT THE WRITTEN PERMISSON OF THE OWNERS. THE USE OF THESE DRAWINGS ARE UNDER ALL CONDITION USED ABOVE, CONTACT ADAM NASSER 0435237853
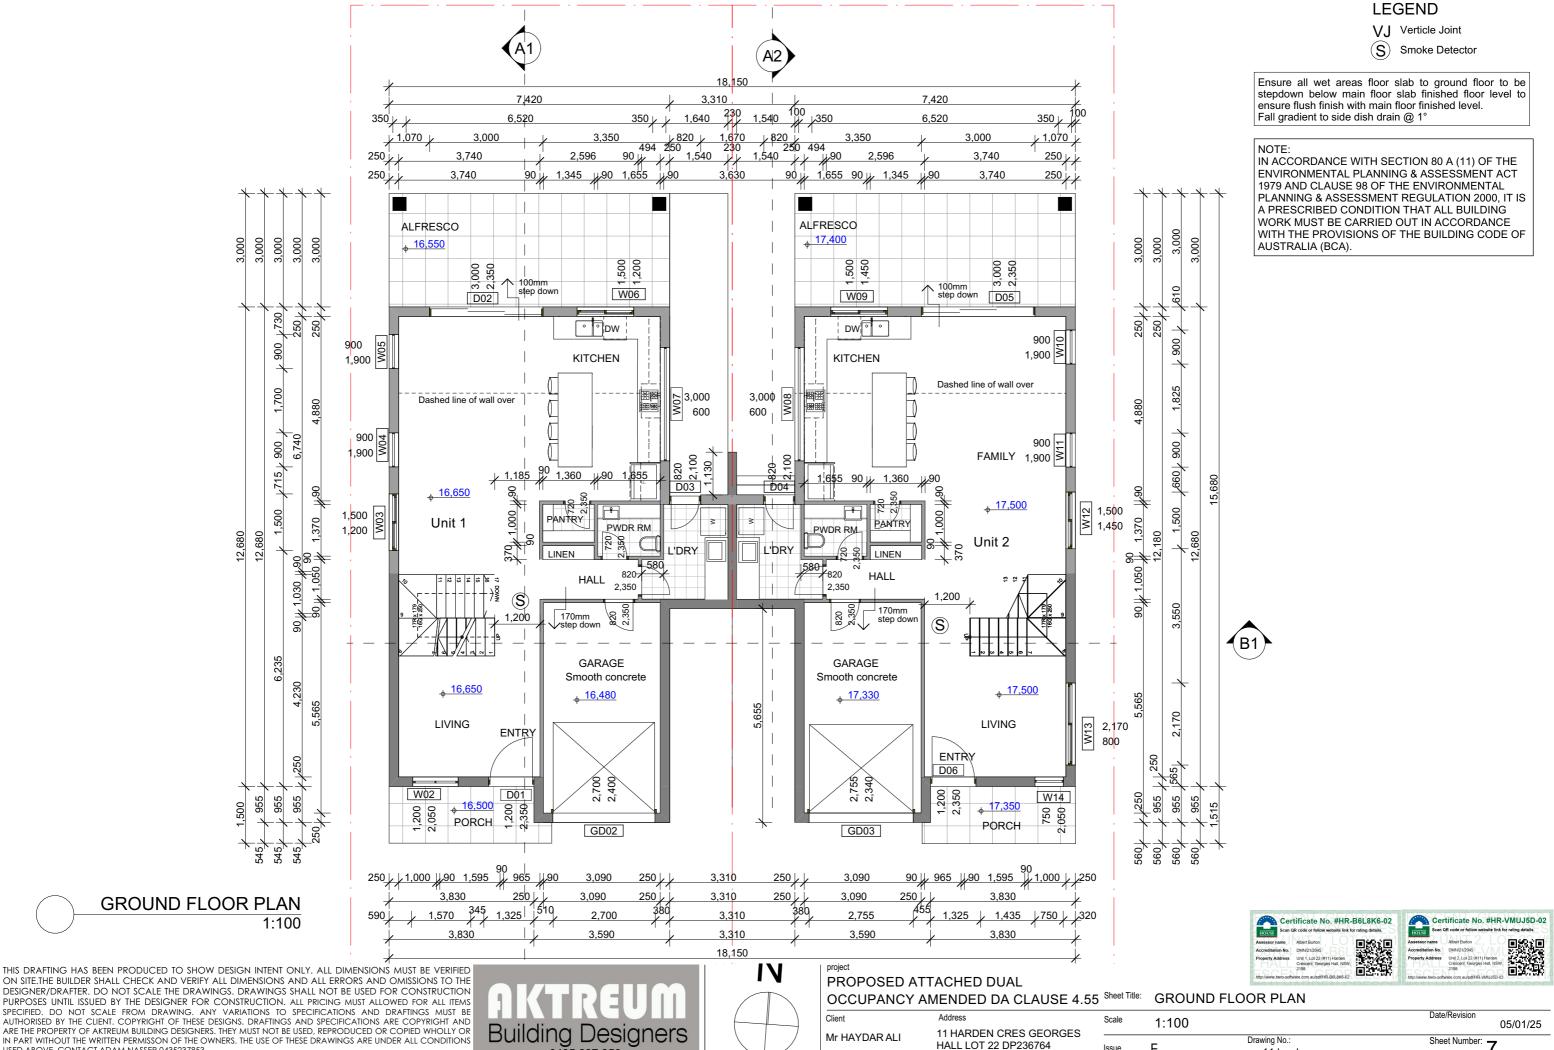
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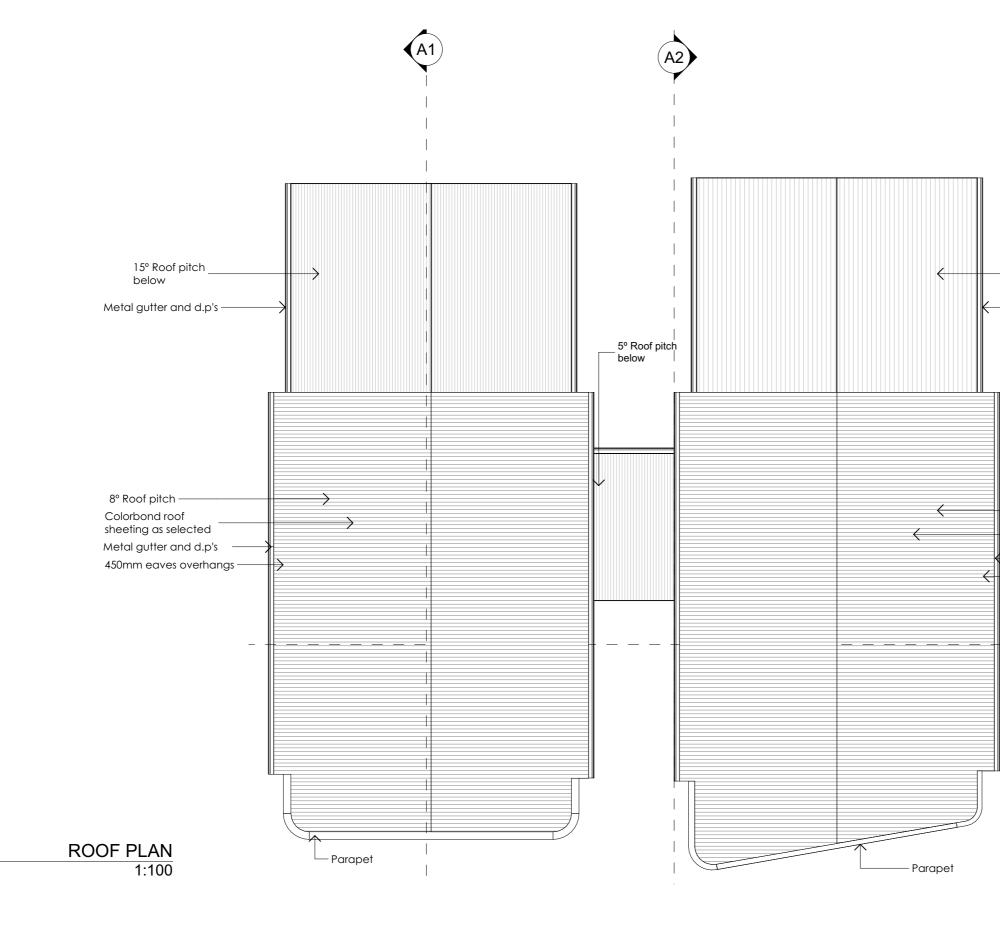
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DESIGNER/DRAFTER. DO NOT SCALE THE DRAWINGS. DRAWINGS SHALL NOT BE USED FOR CONSTRUCTION PURPOSES UNTIL ISSUED BY THE DESIGNER FOR CONSTRUCTION. ALL PRICING MUST ALLOWED FOR ALL ITEMS SPECIFIED, DO NOT SCALE FROM DRAWING, ANY VARIATIONS TO SPECIFICATIONS AND DRAFTINGS MUST BE AUTHORISED BY THE CLIENT. COPYRIGHT OF THESE DESIGNS. DRAFTINGS AND SPECIFICATIONS ARE COPYRIGHT AND ARE THE PROPERTY OF AKTREUM BUILDING DESIGNERS. THEY MUST NOT BE USED, REPRODUCED OR COPIED WHOLLY OR IN PART WITHOUT THE WRITTEN PERMISSON OF THE OWNERS. THE USE OF THESE DRAWINGS ARE UNDER ALL CONDITION USED ABOVE, CONTACT ADAM NASSER 0435237853



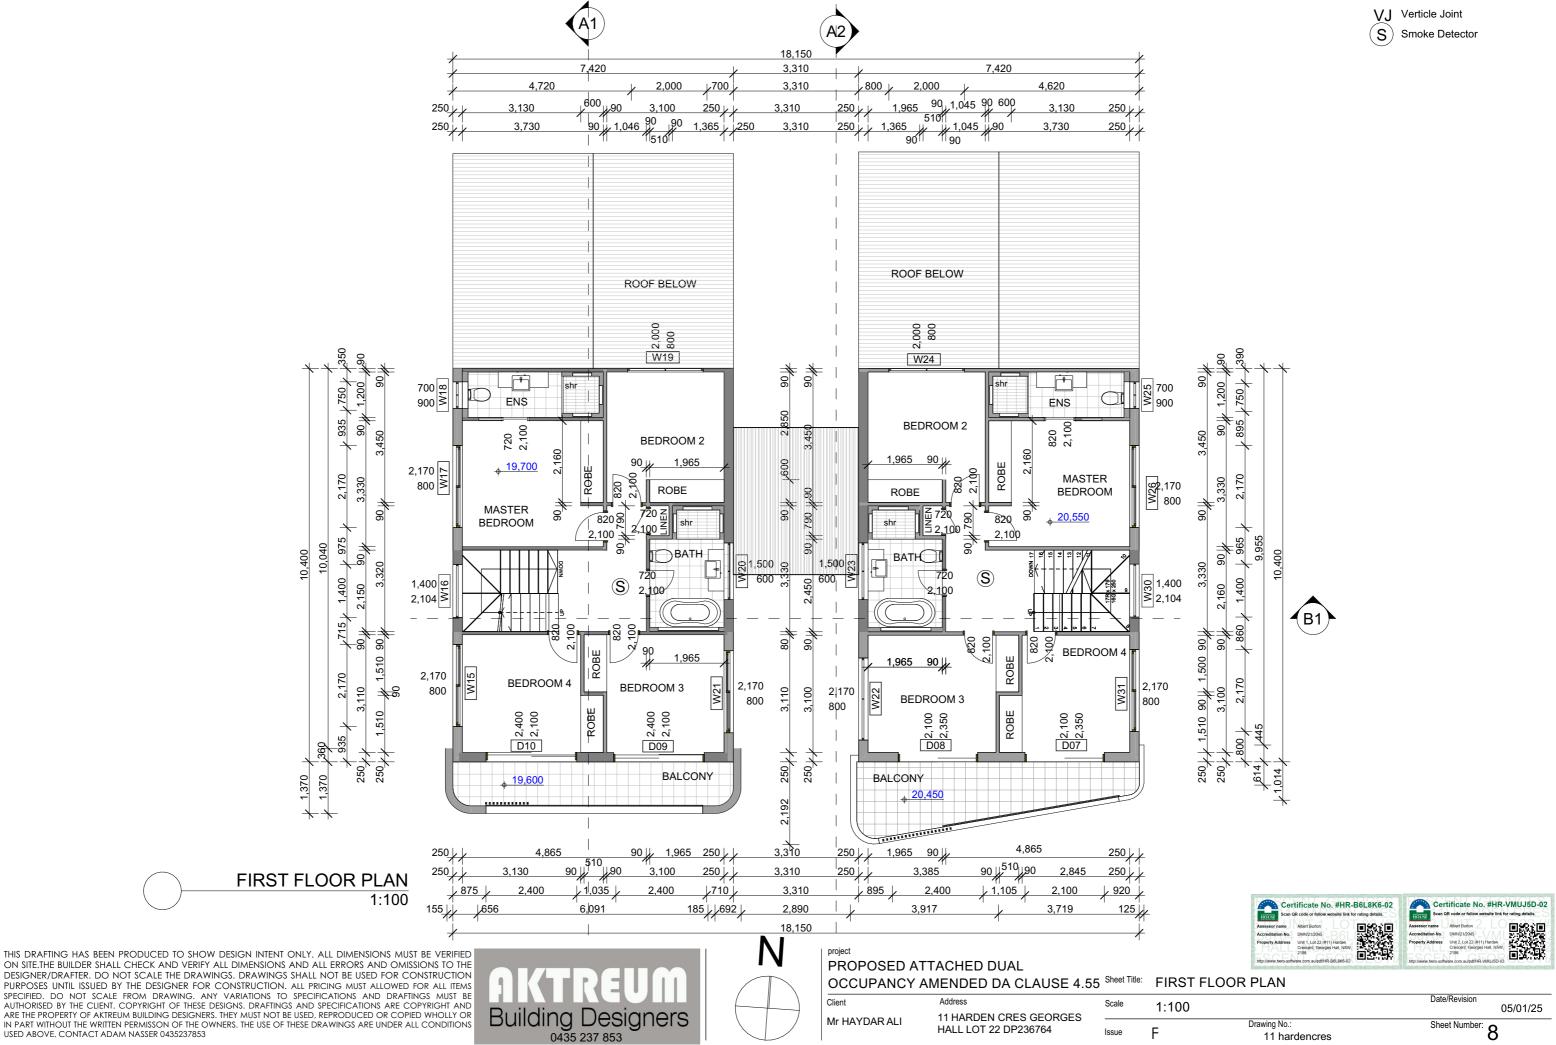

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15° Roof pitch below

Metal gutter and d.p's


- 8° Roof pitch Colorbond roof sheeting as selected - Metal gutter and d.p's 450mm eaves overhangs






Date/Revision

05/01/25

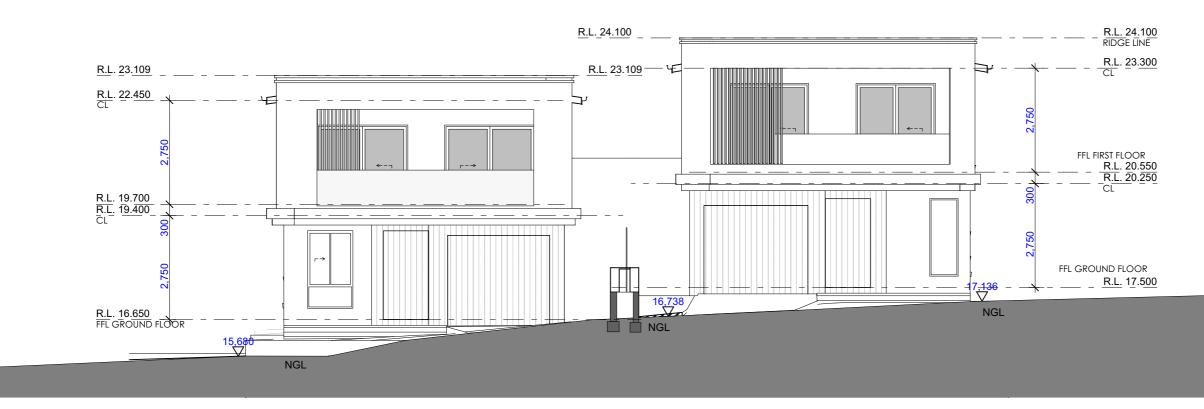

SOUTH ELEVATION



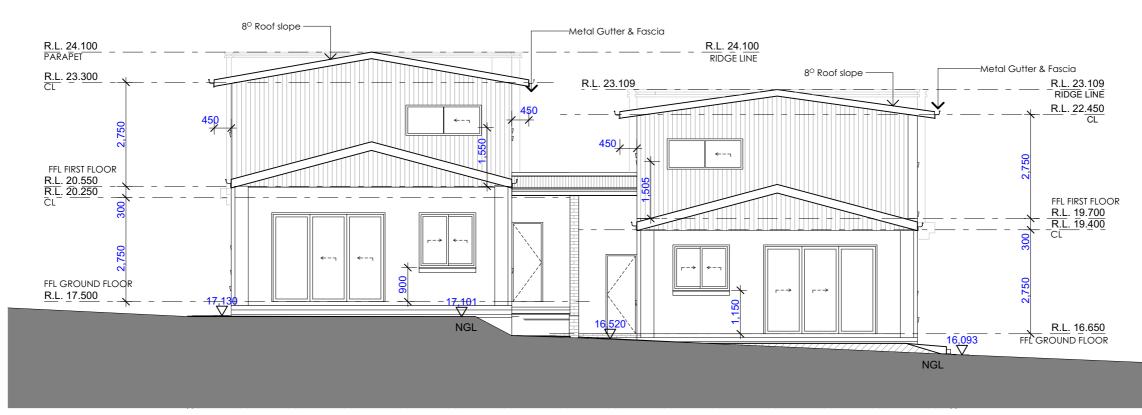

NORTH ELEVATION 1:100

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OCCUPANCY AN	MENDED DA CLAUSE 4.55	Sheet Title:	ELEV			
Client	Address	Scale	1:100			
	11 HARDEN CRES GEORGES		1.100			
Mr HAYDAR ALI	HALL LOT 22 DP236764	Issue	F			




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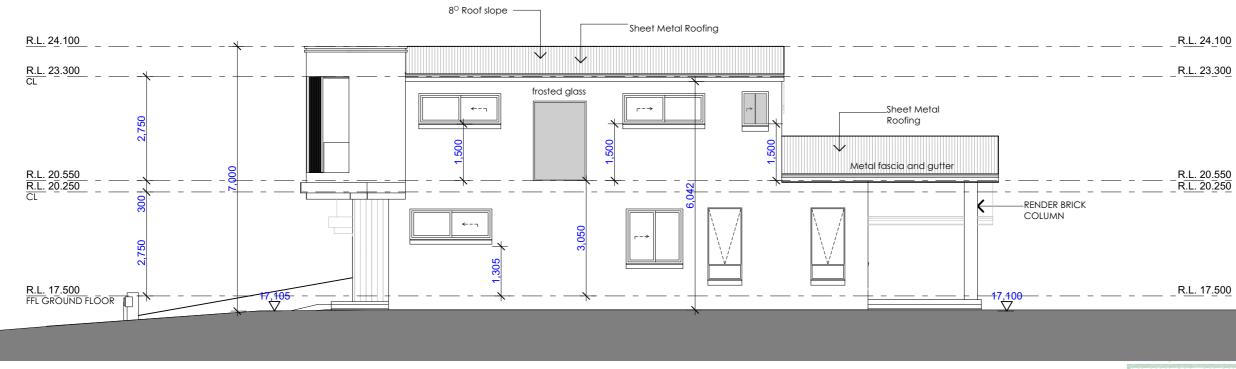
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Drawing No.: 11 hardencres Date/Revision

05/01/25



WEST ELEVATION 1:100

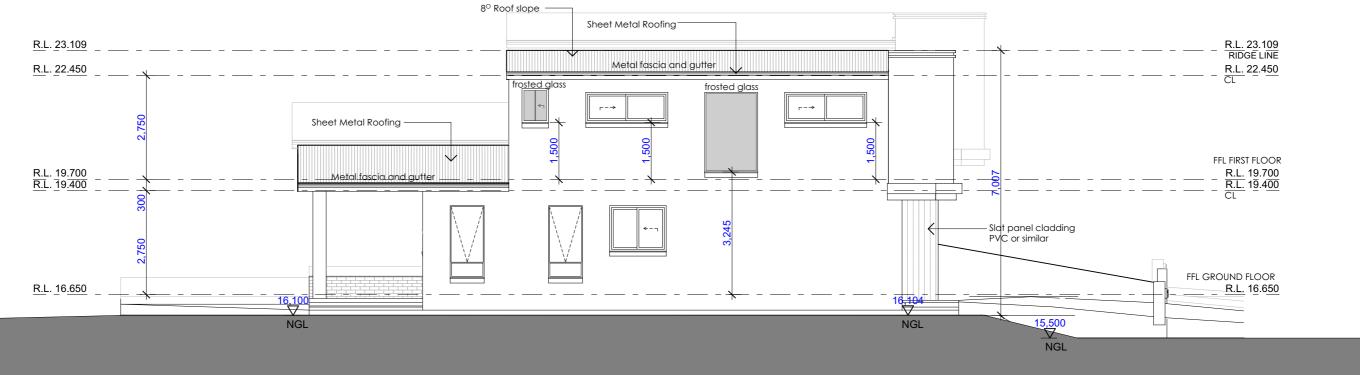

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EAST ELEVATION 1:100

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OCCUPANCY A	MENDED DA CLAUSE 4.55	Sheet Title:	ELE
Client	Address	Scale	1:10
Mr HAYDAR ALI	11 HARDEN CRES GEORGES HALL LOT 22 DP236764	Issue	F


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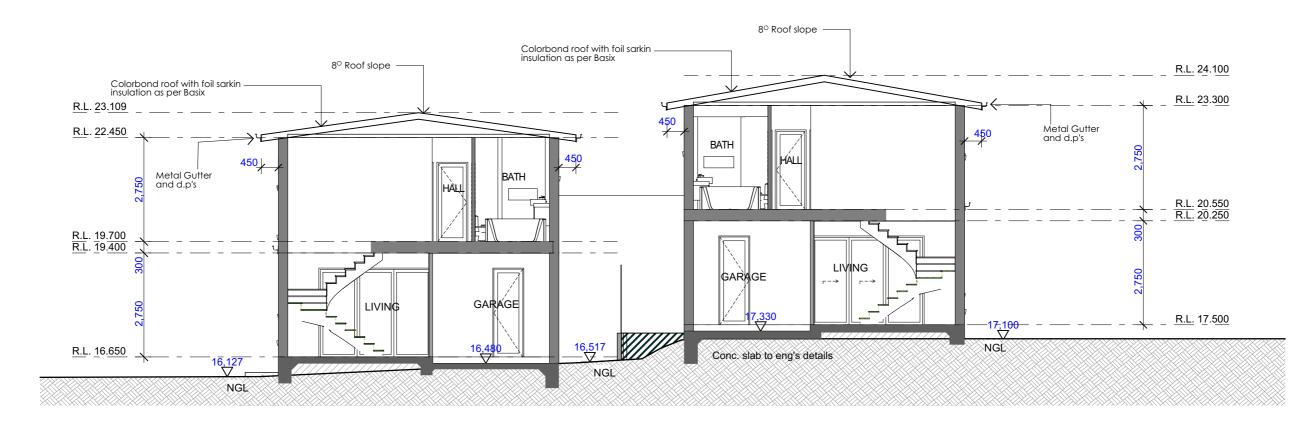


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Client	Address 11 HARDEN CRES GEORGES	Scale	1:10
Mr HAYDAR ALI	HALL LOT 22 DP236764	Issue	F



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Date/Revision 00 05/01/25 Sheet Number: 12 Drawing No. 11 hardencres

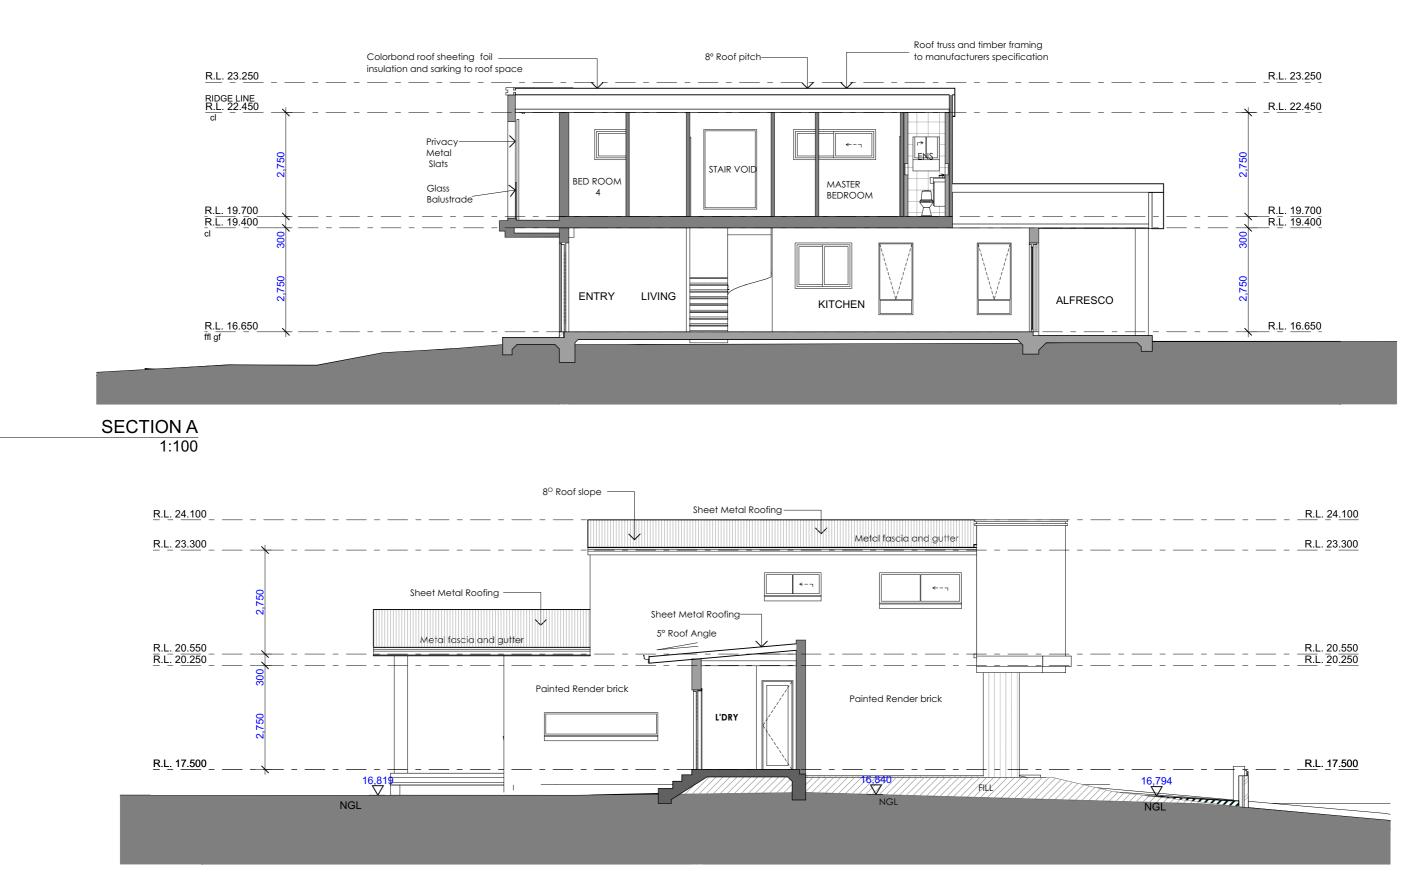

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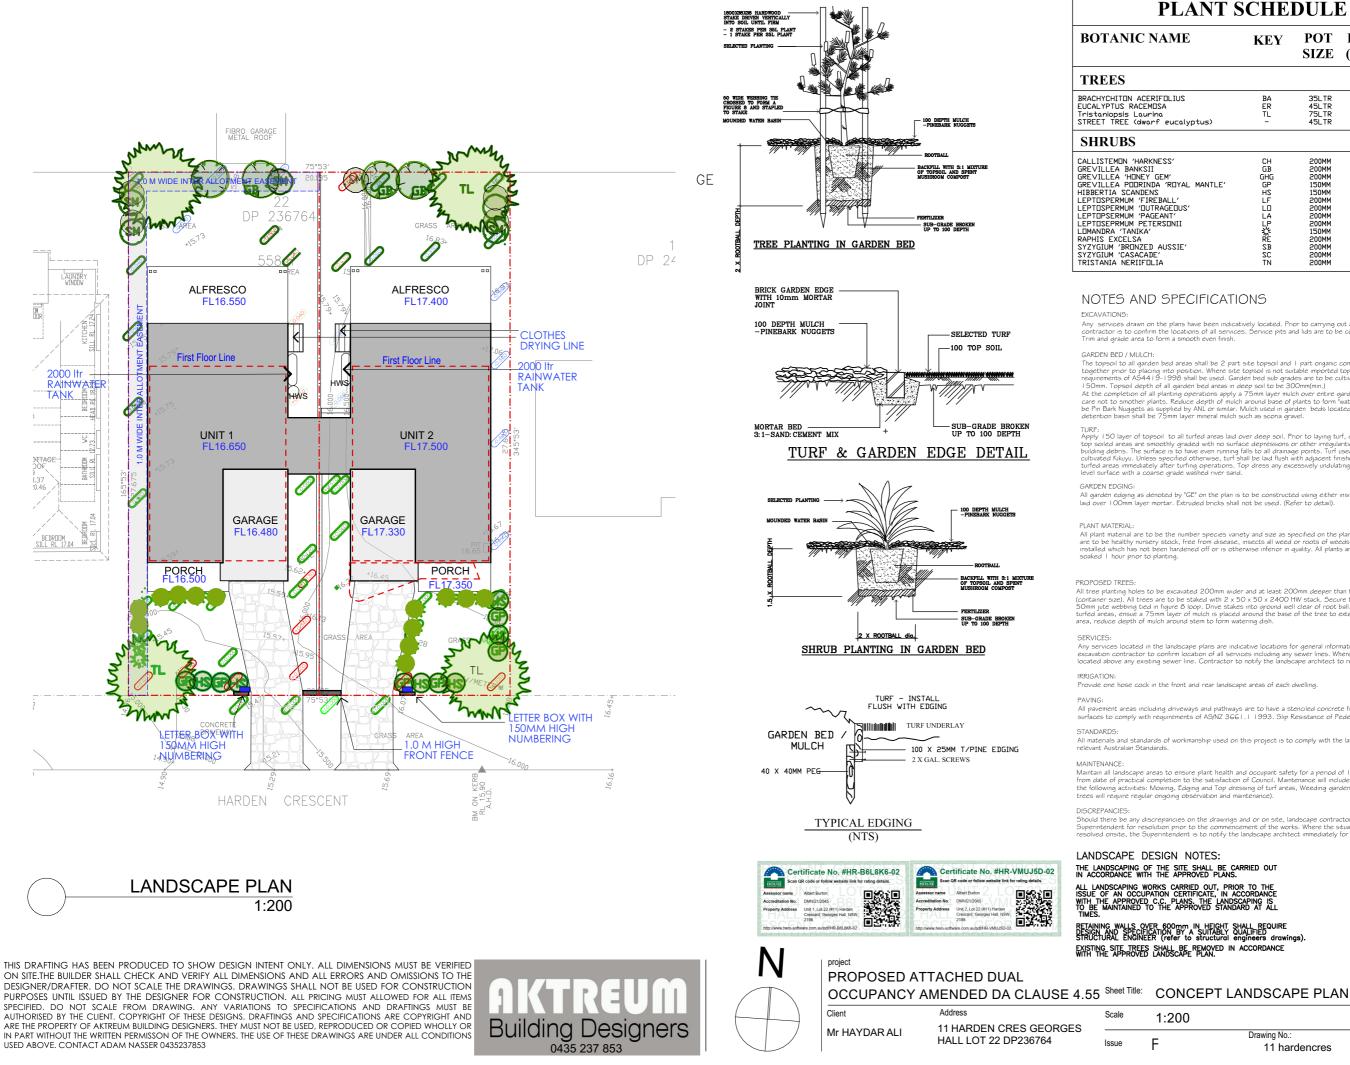






Drawing No. 11 hardencres Date/Revision

05/01/25



ANT SCHEDULE											
E	KEY	POT SIZE	HT (M)	WTH (M)							
21	BA ER TL	35LTR 45LTR 75LTR	13 13 10	5 10 8							
alyptus)	-	45LTR	7	8 3							
	СН	200MM	2	2							
'AL MANTLE'	GH GHG GP HS LF	200MM 200MM 150MM 150MM 200MM	3 3 0.3 0.3 1.5	2 2 1.5 1.5 1.5							
-S,		200MM 200MM	1.5 1.5	1.5 1.5							
I	LP KRE	200MM 150MM 200MM	3 0.6 2	2 0.6 2							
E'	SB SC TN	200MM 200MM 200MM	2.5 3 3	กรา							

Any services drawn on the plans have been indicatively located. Prior to carrying out any excavations, the contractor is to confirm the locations of all services. Service pits and lids are to be covered by any materials Trim and grade area to form a smooth even finish.

The topsoil to all garden bed areas shall be 2 part site topsoil and 1 part organic compost thoroughly mixed The topsoil to all garden bed areas shall be 2 part site topsoil and 1 part organic composit thoroughly mixed together prior to placing into position. Where site topsoil is not suitable imported topsoil meeting the requirements of A54419-1998 shall be used. Garden bed sub grades are to be cultivated to a depth of 150mm. Topsoil depth of all garden bed areas in deep soil to be 300mm(min.) At the completion of all planting operations apply a 75mm layer mulch over entire garden bed / planter taking care not to smother plants. Reduce depth of mulch around base of plants to form "watering dish". Mulch to be Rn Bark Wuggets as supplied by ANL or similar. Mulch used in garden beds located within an onsite detention basin shall be 75mm layer mineral mulch such as scona gravel.

TURF: Apply 150 layer of topsoil to all turfed areas laid over deep soil. Prior to laying turf, contractor to ensure all top soiled areas are smoothly graded with no surface depressions or other irregularities, large stones or building debris. The surface is to have even running fails to all dranage points. Turf used for this site shall be cultivated Kluyu. Unless specified otherwise, turf shall be laid flush with adjacent finished surface levels. Water turfed areas immediately later turfing operations. Top dress any excessively undulating areas to form a smooth level surface with a coarse grade washed river sand.

All garden edging as denoted by "GE" on the plan is to be constructed using either insitu concrete or brick laid over 1 OOmm layer mortar. Extruded bricks shall not be used. (Refer to detail).

All plant material are to be the number species variety and size as specified on the plant schedule. The plants are to be healthy nursery stock, free from disease, insects all weed or roots of weeds. No plant is to be installed which has not been hardened off or is otherwise inferior in quality. All plants are to be thoroughly soaked 1 hour prior to planting.

All tree planting holes to be excavated 200mm wider and at least 200mm deeper than the root ball size The the planting disclose the behavior of the staked with 2 x 50 x 50 x 2400 HW stack. Secure tree to stake using 50mm jute webbing tied in figure δ loop. Drive stakes into ground well clear of root ball. Where trees are turfed areas, ensue a 75mm layer of mulch is placed around the base of the tree to extent of the excavated area, reduce depth of mulch around stem to form watering dish.

DERVICED: Any services located in the landscape plans are indicative locations for general information only. Prior to excavation contractor to confirm location of all services including any sewer lines. Where the proposed tree located above any existing sewer line. Contractor to notify the landscape architect to relocate tree.

All pavement areas including driveways and pathways are to have a stericled concrete finish. All pavement surfaces to comply with requirements of AS/NZ 3661.1 1993. Slip Resistance of Pedestrian Surface.

All materials and standards of workmanship used on this project is to comply with the latest revision of the

Maintain all landscape areas to ensure plant health and occupant safety for a period of 12 month beginning from date of practical completion to the satisfaction of Council. Maintenance will include but is not limited to the following activities: Mowing, Edging and Top dressing of turf areas, Weeding garden beds and turf areas. (All trees will require regular ongoing observation and maintenance).

Should there be any discrepancies on the drawings and or on site, landscape contractor to notify the Superintendent for resolution prior to the commencement of the works. Where the situation is not readily resolved onsite, the Superintendent is to notify the landscape architect immediately for correction.

Date/Revision

													١	Nindow List	
ID	W02	W03	W04	W05	W06	W07	W08	W09	W10	W11	W12	W13	W14	W15	W1
W x H Size	1,200×2,050	1,500×1,200	900×1,900	900×1,900	1,500×1,200	3,000×600	3,000×600	1,500×1,450	900×1,900	900×1,900	1,500×1,450	2,170×800	750×2,050	2,170×800	1,400×2,10
3D Front View															

ID	6 W17	W18	W19	W20	W21	W22	W23	W24	W25	W26	W30	W31
W x H Size	4 2,170×800	700×900	2,000×800	1,500×600	2,170×800	2,170×800	1,500×600	2,000×800	700×900	2,170×800	1,400×2,104	2,170×800
3D Front View												

WINDOW SCHEDULE

								Doo	r List					
ID	D01	D02	D03	D04	D05	D005	D06	D006	D006	D07	D007	D08	D008	D09
W x H Size	1,200×2,350	3,000×2,350	820×2,100	820×2,100	3,000×2,350	720×2,350	1,200×2,350	720×2,100	820×2,100	2,100×2,350	820×2,100	2,100×2,350	820×2,100	2,400×2,100
3D Front View														
ID	D10	GD0	02 GE	003										
W x H Size	2,400×2,100	2,700×2,40	00 2,755×2,3	40										
3D Front View				-										

DOOR SCHEDULE

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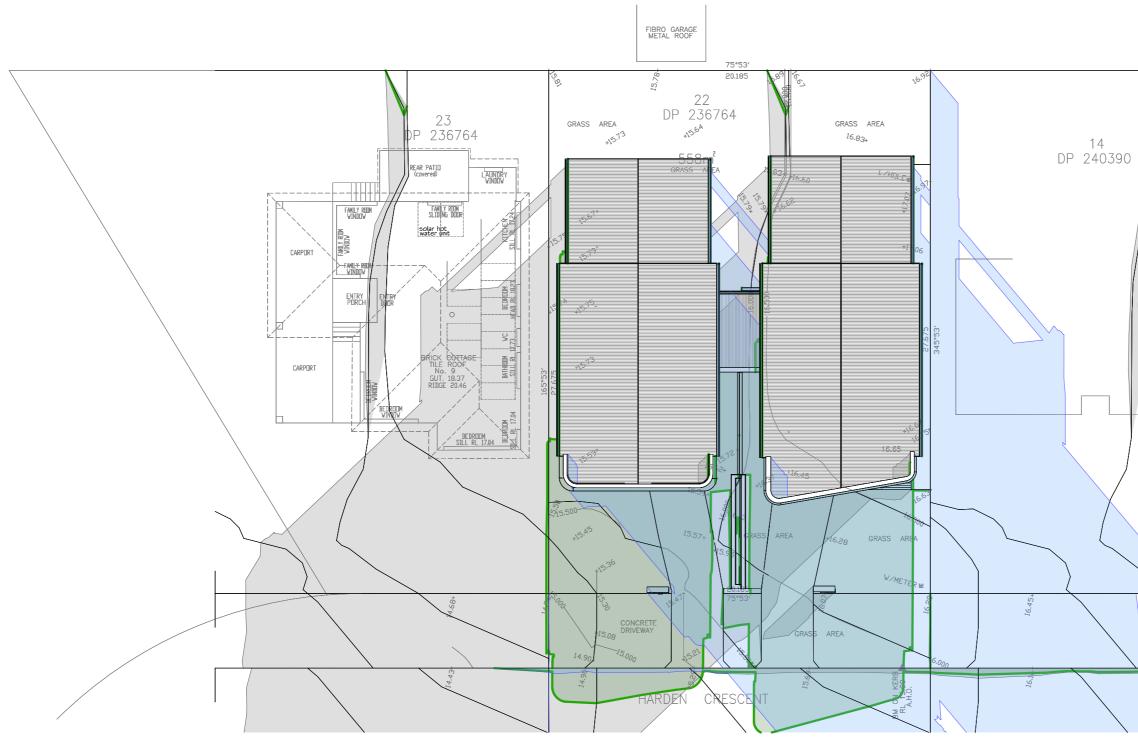
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OCCUPANCY	AMENDED DA CLAUSE 4.5	5 Sheet Title:	WINI
Client	Address	Scale	1.1
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	HALL LOT 22 DP236764	Issue	F



IDOWS AND DOORS SCHEDULE



SHADOW DIAGRAMS 21 JUNE 1:200

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